STORMWATER MANAGEMENT PLAN

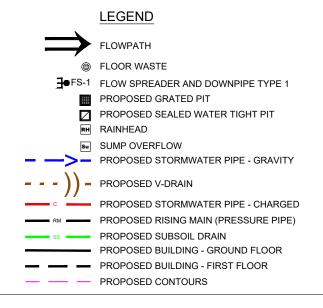
21 NARELLE CRESCENT GREENACRE



BE (Civil), MIEAust, CPEng No. 449924

SHEET	INDEX:	
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SHEET No.	TITLE	AMMENDMENT No.
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2	STORMWATER DETAIL PLAN	1
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NEW DOWNPIPE - 100Ø



EXISTING DOWNPIPE - 100Ø

TK 0.00 TOP OF KERB LEVEL

+ 00.00 EXISTING SURFACE LEVEL 00.00 PROPOSED SURFACE LEVEL

SEALED INSPECTION OPENING

TERRACE/BALCONY

BASIX ROOF AREA DRAINING TO RAINWATER TANK

AREA BYPASSING ON-SITE DETENTION TANK

- ALL PROPOSED PITS TO BE 450 x 450 CAST IN-SITU OR PRECAST PITS UNI ESS SHOWN OTHERWISE
- ALL CHARGED LINE PIPES TO BE 100Ø uPVC SEWER CLASS UNLESS SHOWN OTHERWISE
- ALL DOWNPIPES TO BE 90Ø uPVC OR 100 x 50 UNLESS OTHERWISE SHOWN
- ALL NON-PRESSURE STORMWATER PIPES TO BE 1000 uPVC UNLESS SHOWN OTHERWISE
- ALL GRATED DRAINS TO BE MINIMUM 150 WIDE GALVANIZED HEAVY DUTY GRATES.
- ALL NON-TRAFFICABLE PITS TO BE LIGHT DUTY. PITS IN TRAFFICABLE AREAS TO BE HEAVY DUTY
- ALL WORK SHALL BE CARRIED OUT IN ACCORDANCE WITH COUNCILS SPECIFICATIONS.
- ALL PITS GREATER THAN 1.2m DEPTH SHALL INCLUDE STEP IRONS AND HAVE MINIMUM CLEAR DIMENSIONS OF
- ALL PITS ARE TO BE BENCHED TO ALLOW SMOOTH FLOW OF WATER THROUGH PITS
- ALL DOWNPIPES SHALL CONFORM TO AS/NZS 1866 FOR ALUMINIUM PIPES AND AS 1254, AS/NZS 1260, AS 1273, AS/NZS 1477, AS/NZS 2179.2 AND AS 2032 FOR uPVC PIPES
- ALL BOX GUTTERS SHALL COMPLY WITH AS/NZS 2179.1
- ALL BOX GUTTERS SHALL BE CONSTRUCTED WITH A MINIMUM 1:200 GRADE TO SUMP/DOWNPIPES
- 13. ALL DRAINAGE WORKS SHALL BE IN ACCORDANCE WITH

DOWNPIPE	CROSS SECTION AREA MIN. (mm2)	DOWNPIPE SIZES				
TYPE		ROUND	RECTANGULAR			
1	8600	90Ø	100 X 50			
2	11000	100Ø	100 X 75			
3	12900	125Ø	100 X 75			
4	17100	125Ø	100 X 100			
5	21500	150Ø	125 X 100			
6	24700	150Ø	150 X 150			

FOR DA APPROVAL

SURVEYOR	0	DA ISSUE	10/08/23				С
C & A SURVEYORS	1	DA ISSUE - AMENDMENTS TO FLOOR PLANS	07/11/23				AE
ARCHITECT							49
BELLEVUE ARCHITECTS							R
CONSULTANT	No.	AMMENDMENT	DATE	No.	AMMENDMENT	DATE	M
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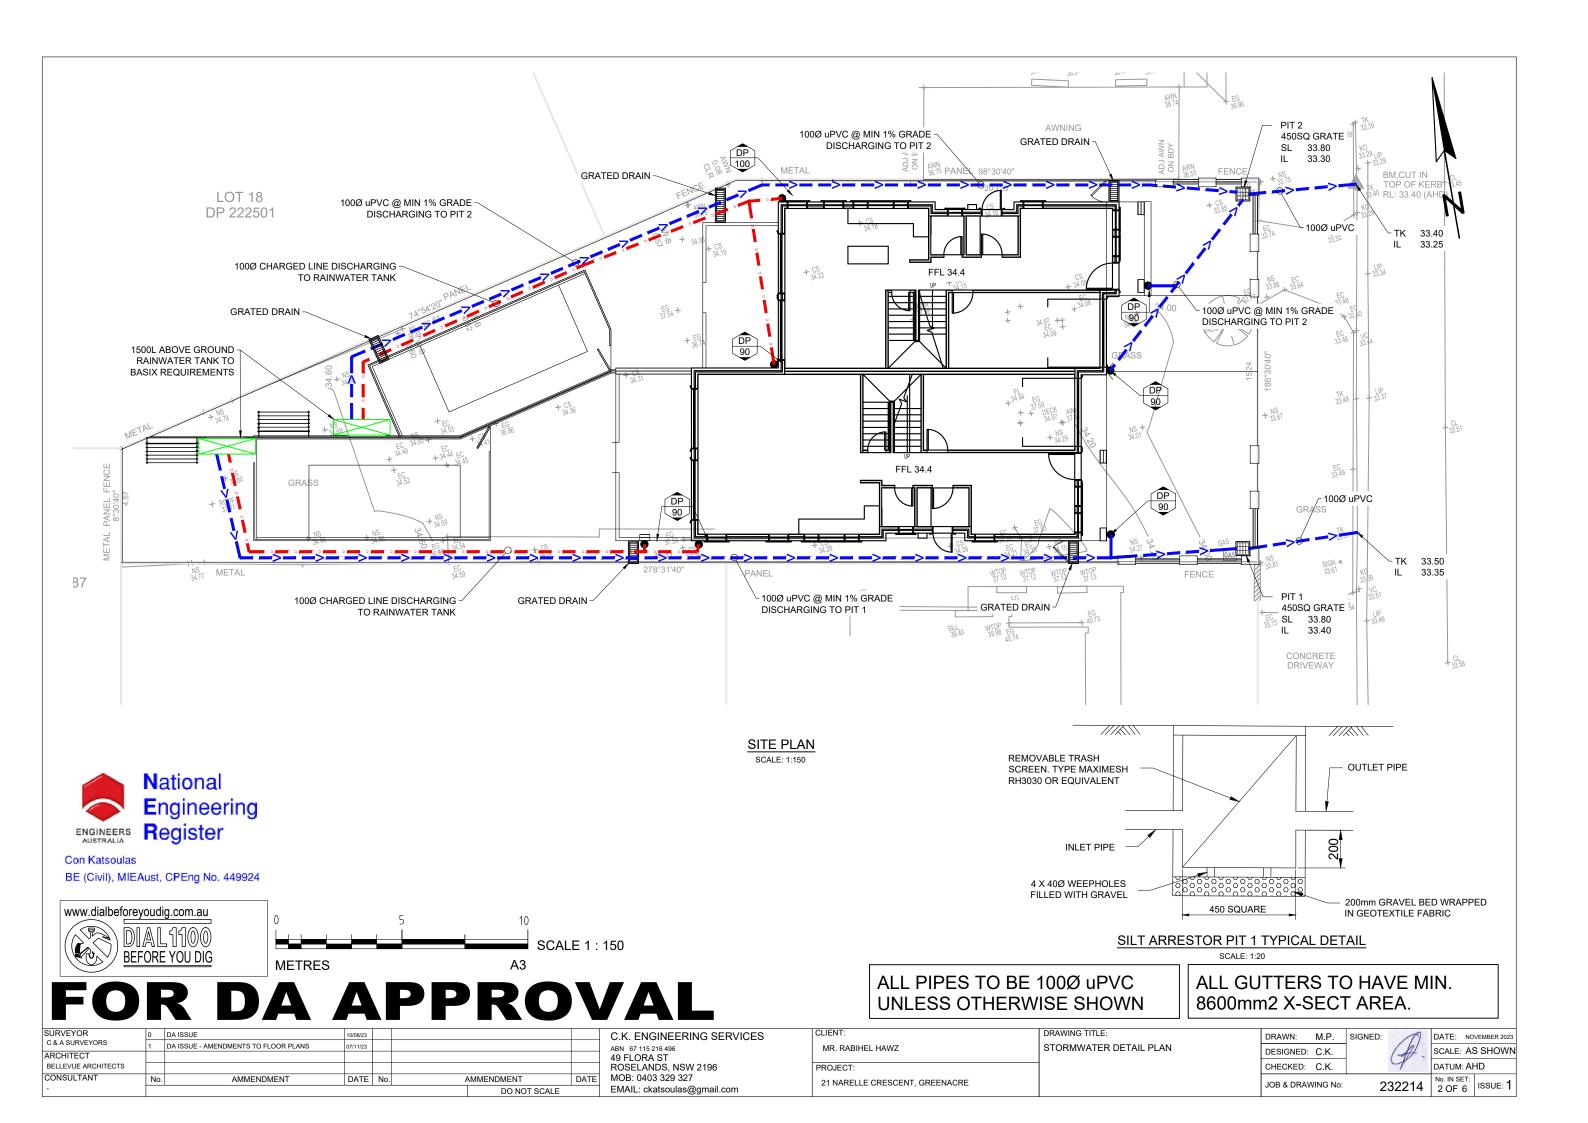
C.K. ENGINEERING SERVICES 49 FLORA ST ROSELANDS, NSW 2196 MOB: 0403 329 327

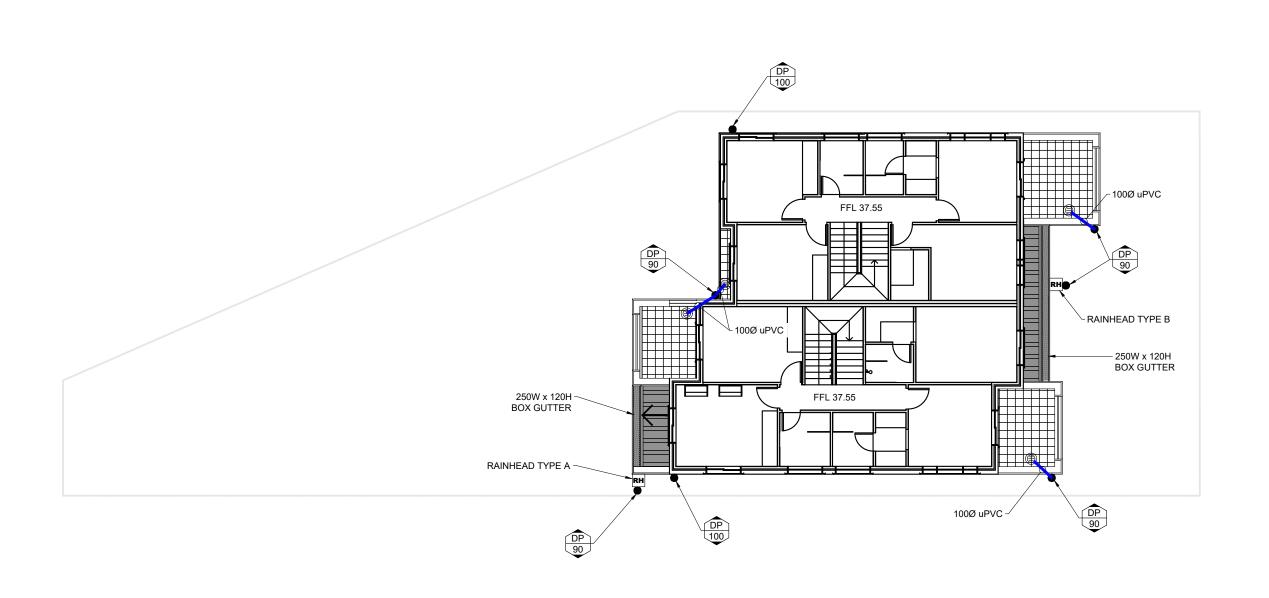
MR. RABIHEL HAWZ 21 NARELLE CRESCENT, GREENACRE

DRAWING TITLE INDEX

DRAWN: M.P. SIGNED: JOB & DRAWING No

DATE: NOVEMBER 2023 SCALE: AS SHOWN DATUM: AHD lo. IN SET:







FIRST FLOOR PLAN

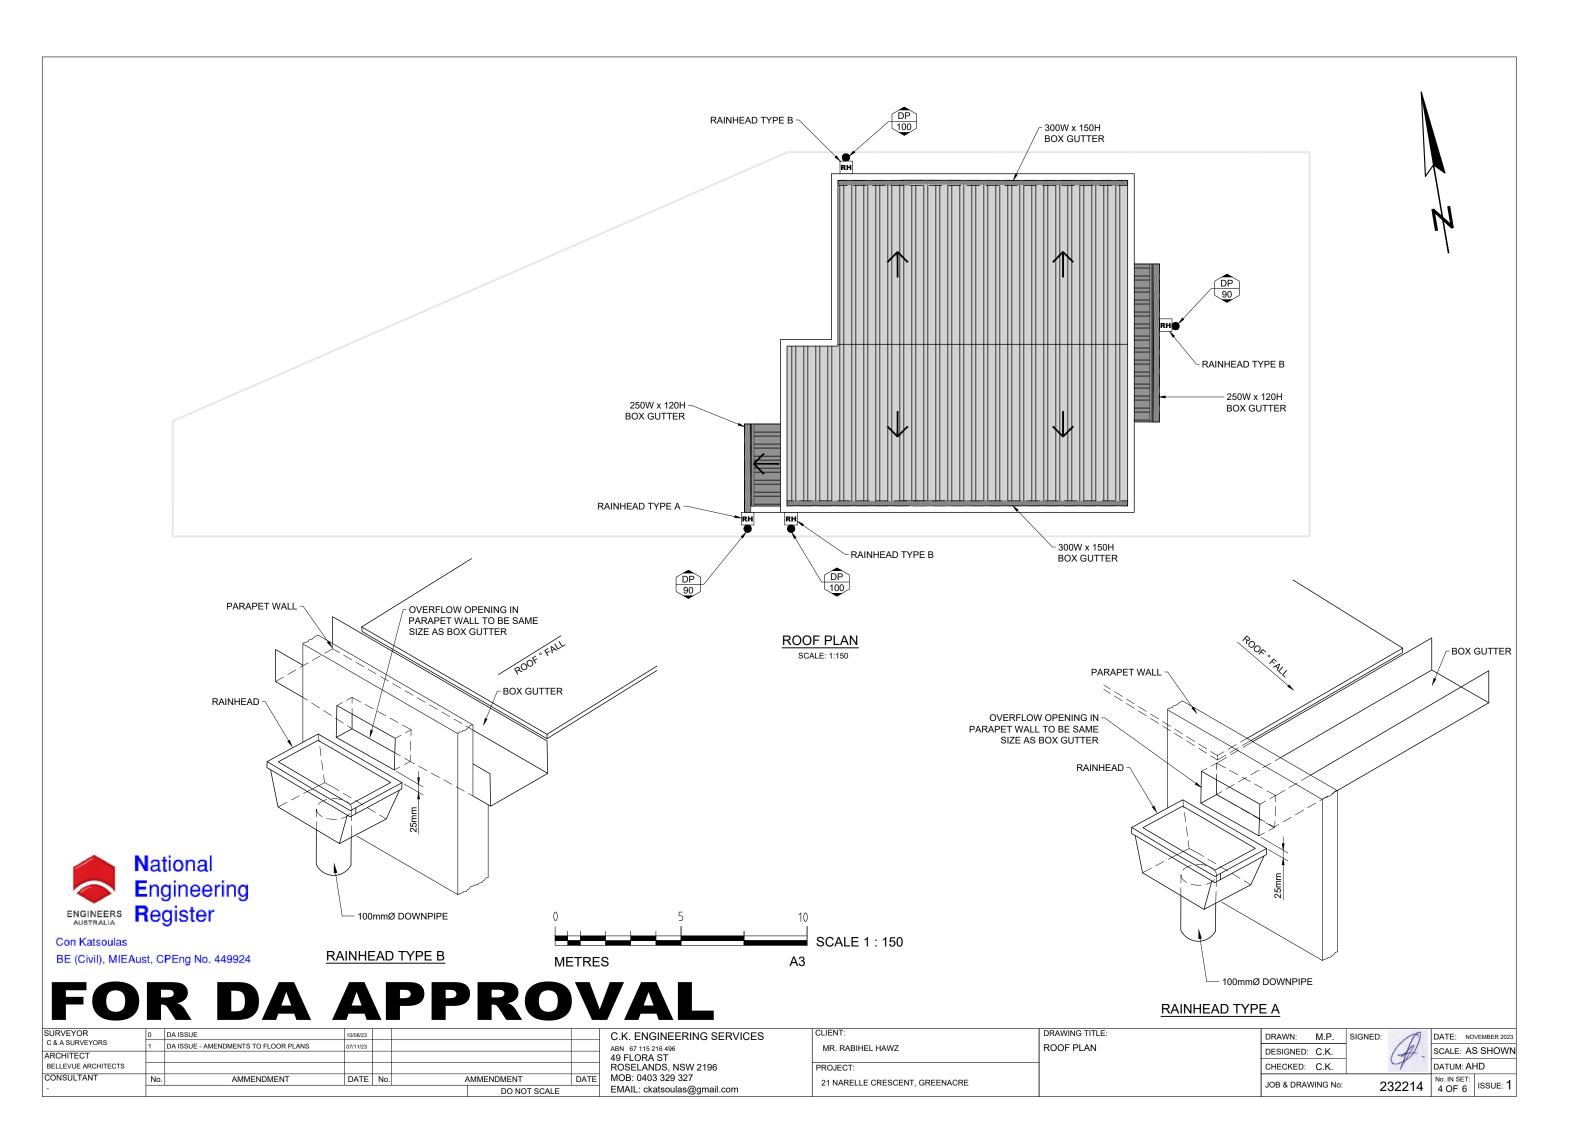


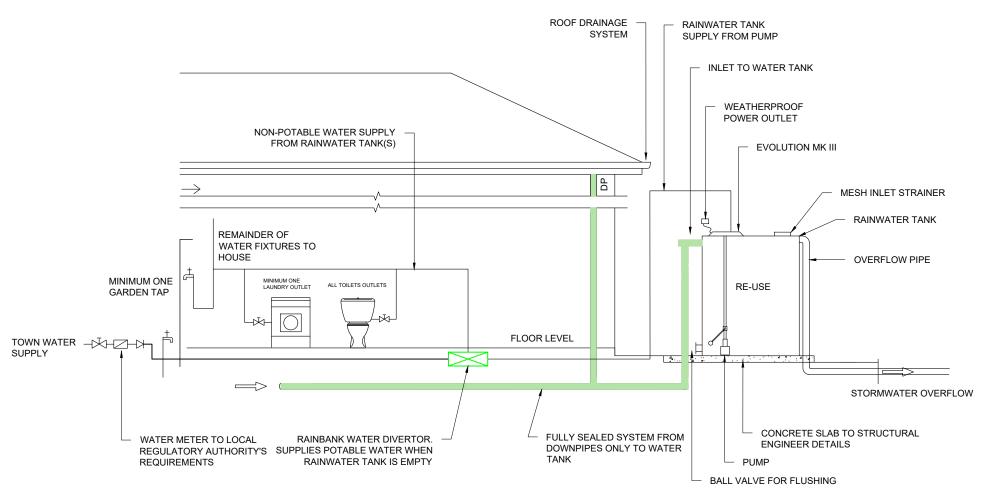
Con Katsoulas
BE (Civil), MIEAust, CPEng No. 449924
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SURVEYOR	0	DA ISSUE	10/08/23			C.K. ENGINEERING SERVICES	CLIENT:	DRAWING TITLE:	DRAWN:	M.P.	SIGNED:	DATE: NOVEMBER 2023
C & A SURVEYORS	1	DA ISSUE - AMENDMENTS TO FLOOR PLANS	07/11/23			ABN 67 115 216 496	MR. RABIHEL HAWZ	FIRST FLOOR PLAN	DESIGNED:	CK	1 1	SCALE: AS SHOWN
ARCHITECT						49 FLORA ST			-		(-70	7
BELLEVUE ARCHITECTS						ROSELANDS, NSW 2196	PROJECT:		CHECKED:	C.K.	7	DATUM: AHD
CONSULTANT	No.	AMMENDMENT	DATE No.	o. AMMENDMENT	DATE	MOB: 0403 329 327	21 NARELLE CRESCENT, GREENACRE		JOB & DRA	MING No:	2222	No. IN SET:
-				DO NOT SCALE		EMAIL: ckatsoulas@gmail.com			JOB & DIVA	WING NO.	23221	4 3 OF 6 ISSUE: 1





TYPICAL RAINWATER TANK SYSTEM



Con Katsoulas BE (Civil), MIEAust, CPEng No. 449924

FOR DA APPROVAL

C & A SURVEYORS DA ISSUE - AMENDMENTS TO FLOOR PLANS ARCHITECT BELLEVUE ARCHITECTS CONSULTANT DATE No. AMMENDMENT AMMENDMENT DO NOT SCALE

C.K. ENGINEERING SERVICES 49 FLORA ST ROSELANDS, NSW 2196 MOB: 0403 329 327

EMAIL: ckatsoulas@gmail.com

CLIENT DRAWING TITLE: MR. RABIHEL HAWZ RAINWATER TANK DETAIL 21 NARELLE CRESCENT, GREENACRE

RAINWATER TANK NOTES

RAINWATER TANKS ARE TO BE:

ERECTED ON A SELF-SUPPORTING BASE IN THE APPROVED LOCATION ON THE PROPERTY IN ACCORDANCE WITH THE STAMPED-APPROVED SITE PLANS FOR THE DEVELOPMENT,

STRUCTURALLY SOUND AND CONSTRUCTED IN ACCORDANCE WITH AS/NZS 3500 1.2- 1998: NATIONAL PLUMBING AND DRAINAGE - WATER SUPPLY - ACCEPTABLE SOLUTIONS,

FULLY ENCLOSED AND ALL OPENINGS SEALED TO PREVENT ACCESS BY MOSQUITOES,

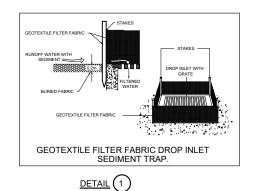
FITTED WITH A FIRST FLUSH DEVICE,

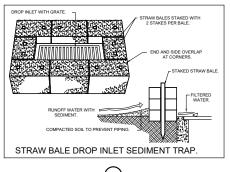
FITTED WITH A TRICKLE SYSTEM TO TOP UP FROM MAINS WATER, PROVIDED WITH AN AIR GAP, AND

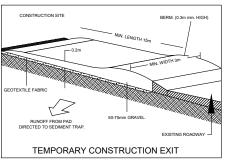
INSTALLED BY A LICENSED PLUMBER IN ACCORDANCE WITH SYDNEY WATER'S "PLUMBING REQUIREMENTS INFORMATION FOR RAINWATER TANK SUPPLIERS AND PLUMBERS APRIL 2003" AND THE NSW CODE OF

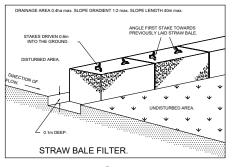
PRACTICE: PLUMBING AND DRAINAGE.

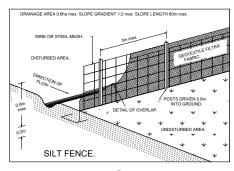
RAWN:	M.P.	SIGNED:	17	DATE: NO	VEMBER 2023
ESIGNED:	C.K.		(-A) -	SCALE: AS	SHOWN
HECKED:	C.K.		4	DATUM: Al	HD
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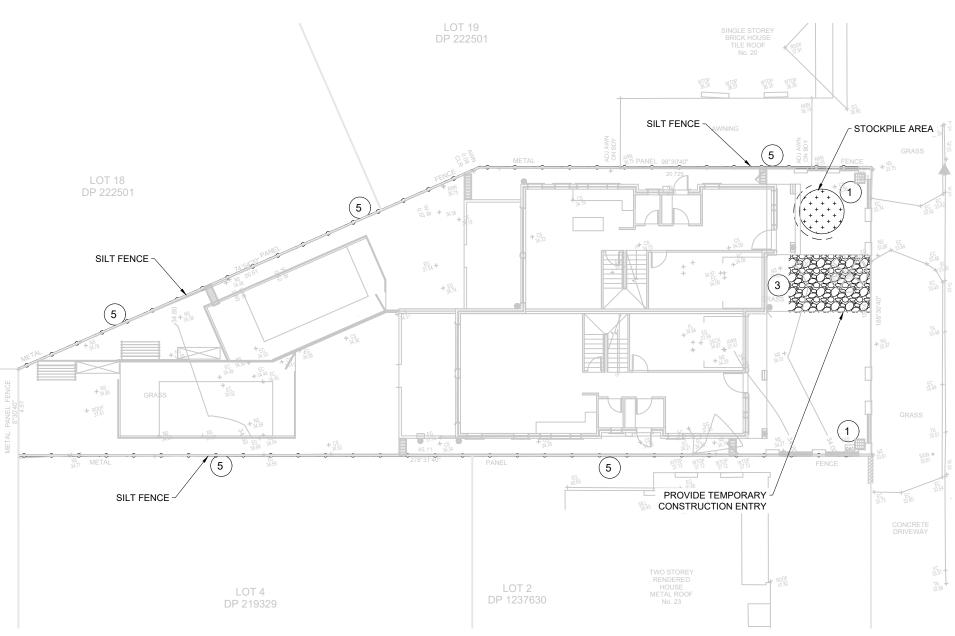


DETAIL (2)

DETAIL (3)

DETAIL 4

DETAIL (5)



EROSION CONTROL NOTES:

- ALL WORK SHALL BE CARRIED OUT IN ACCORDANCE WITH COUNCIL'S
 STANDARD SPECIFICATIONS AND TO THE SATISFACTION OF COUNCIL'S
 ENGINEER
 - EROSION AND SEDIMENTATION CONTROLS SHALL BE CONSTRUCTED AS SHOWN ON SHEET 2 AND 3 OF THIS PLAN AND/OR WHERE DIRECTED BY COUNCIL'S ENGINEER.
- 3. SEDIMENTATION AND EROSION CONTROL DEVICES SHALL BE IMPLEMENTED PRIOR TO OR IN CONJUNCTION WITH THE FIRST PHASE OF EARTHWORKS AND SHALL BE REMOVED ONLY WHEN THE AREAS ABOVE IT HAVE BEEN STABILISED. EACH SEDIMENTATION AND EROSION CONTROL DEVICE SHALL BE INSPECTED AFTER EACH STORM FOR STRUCTURAL DAMAGE OR CLOGGING BY SILT AND OTHER DEBRIS AND PROMPTLY DESILTED, REPAIRED OR REPLACED IF REQUIRED.
- TOPSOIL STOCKPILES SHALL BE LOCATED OUTSIDE HAZARD AREAS SUCH AS DRAINAGE DEPRESSIONS.
- ALL AREAS NOT SUBJECT TO CONSTRUCTION WORKS SHALL BE RETAINED FREE FROM DISTURBANCE OR DAMAGE FOR THE DURATION OF THE WORKS.
- TREES TO BE RETAINED SHALL BE PROTECTED DURING SITE WORKS AND CONSTRUCTION BY THE ERECTION OF SOLID BARRICADES AT THE DRIP LINE OR AS SPECIFIED BY COUNCIL'S ENGINEER.
- 7. THE DEVELOPER OR CONTRACTOR WILL TAKE ALL MEASURES TO PREVENT DAMAGE TO TREES AND ROOT SYSTEMS DURING SITE WORKS AND CONSTRUCTION ACTIVITIES INCLUDING THE PROVISION OF WATER, SEWERAGE AND STORMWATER DRAINAGE SERVICES. IN PARTICULAR, WORKS, ERECTION OF STRUCTURES, EXCAVATION OR CHANGES TO SOIL LEVELS WITHIN 4 METRES OF THE TRUNKS OF TREES TO BE RETAINED ARE NOT PERMITTED UNLESS PART OF THE DEVELOPMENT AS APPROVED, AND THE STORAGE OF SPOIL, BUILDING MATERIALS, SOILS OR THE DRIVING OR PARKING OF ANY VEHICLE OR MACHINERY WITHIN 4 METRES OF THE TRUNK OF A TREE TO BE RETAINED, IS NOT PERMITTED.
- WETTING OF THE SITE SHOULD BE CARRIED OUT AS OFTEN AS NECESSARY AS A FORM OF DUST CONTROL.
 - SILT FENCES TO BE CONSTRUCTED WHERE EVER NATURAL SURFACE SLOPES AWAY FROM DISTURBED AREAS OR WHERE DIRECTED BY THE ENGINEER.

EROSION AND SEDIMENT CONTROL PLAN

National Engineering Register

Con Katsoulas

BE (Civil), MIEAust, CPEng No. 449924

FOR DA APPROVAL

C.K. ENGINEERING SERVICES

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EMAIL: ckatsoulas@gmail.com

CLIENT:

MR. RABIHEL HAWZ

PROJECT:

21 NARELLE CRESCENT, GREENACRE

EROSION AND SEDIMENT CONTROL PLAN

DRAWN: M.P. SIGNED:
DESIGNED: C.K.
CHECKED: C.K.

DATE: NOVEMBER 2023
SCALE: AS SHOWN
DATUM: AHD
No. IN SET: 100US 1

JOB & DRAWING No: 232214 | No. IN SET: 6 OF 6 | ISSUE: 1